

كلية عريس المربية للبنات

MARYAM GIRLS ARABIC COLLEGE


මර්යම් බාලිකා අරාබි විදුහල மர்யம் மகளிர் পிரபுக் கல்லூரி

Barakah Estate, Tharavillu Junction, Battulu-Oya, Sri Lanka. Tel. 0767258899, 0711035303


PROJECT:

ESTIMATE & DRAWING

FOR PROPOSED 1ST FLOOR HOSTAL BUILDING, BUILDING
EXTENTION (20M X 6M) & TOILET COMPLEX (1ST FLOOR) AT
MARYAM GIRLS ARABIC COLLEGE, BARAKAH ESTATE,
THARAVILLU JUNCTION, BATTULU - OYA, SRI LANKA.

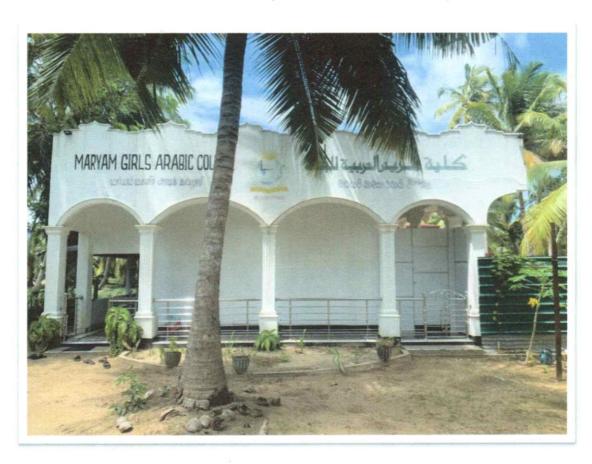

PROJECT DESIGN, DRWANING AND ESTIMATE BY
AJM CONSTRUCTION

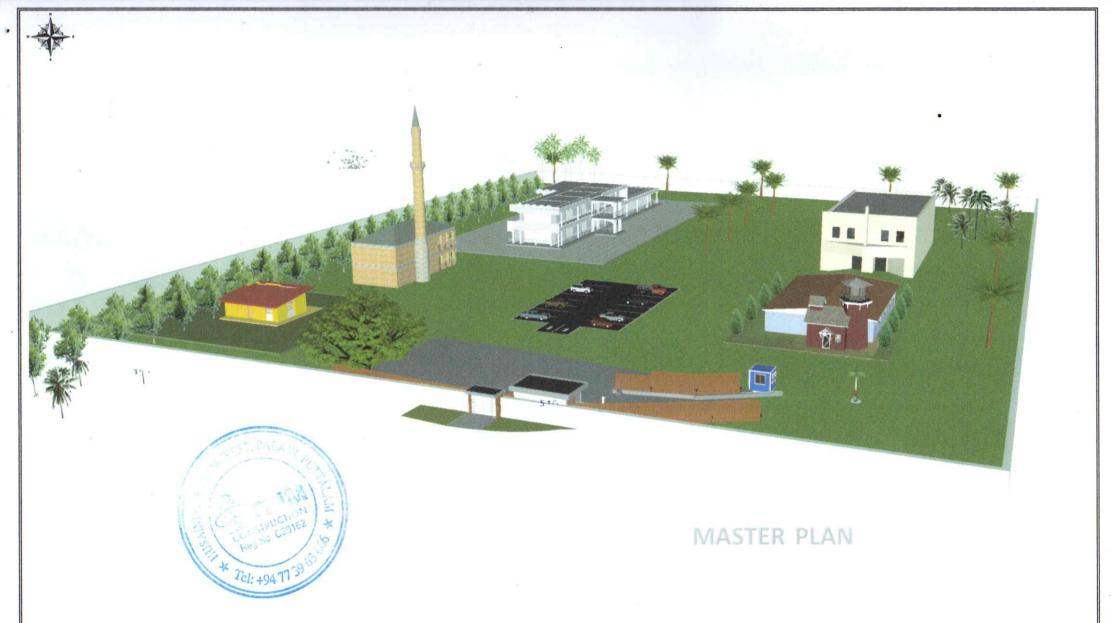

PROJECT:

PROPOSED DRAWIND FOR 1ST FLOOR BUILDING, BUILDING EXTENTION (20M X 6M) & TOILET COMPLEX (1ST FLOOR) AT MARYAM GIRLS ARABIC COLLEGE, BARAKAH ESTATE, THARAVILLU JUNCTION, BATTULU - OYA, SRI LANKA.

DRAWING NO: AJM/D/113

FILE NO: A/D/01

SCALE: AS SHOWN

DATE: 10/12/2023

SHEET SIZE: A-4

CLIENT:

BOARD MEMBERS OF MARYAM GIRLS DRAWN BY : Ale

CHECKED BY : ..

APPROVED BY :



WE BUILD YOUR DREAM





SIDE ELEVATION



PROJECT:

PROPOSED DRAWIND FOR 1ST FLOOR BUILDING, BUILDING EXTENTION (20M X 6M) & TOILET COMPLEX (1ST FLOOR) AT MARYAM GIRLS ARABIC COLLEGE, BARAKÁH ESTATE, THARAVILLU JUNCTION, BATTULU - OYA, SRI LANKA.

DRAWING NO: AJM/D/113

FILE NO: A/D/01

SCALE: AS SHOWN

DATE: ... 0/ 12/2023

SHEET SIZE: A-4

CLIENT:

BOARD MEMBERS OF MARYAM GIRLS ARABIC COLLEGE DRAWN BY: ASL


CHECKED BY :

APPROVED BY :



WE BUILD YOUR DREAM



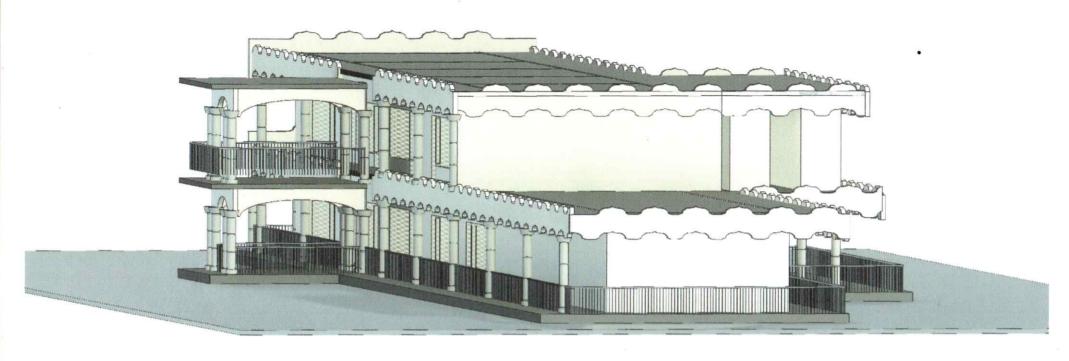

SIDE ELEVATION



PROJECT:

PROPOSED DRAWIND FOR 1ST FLOOR BUILDING, BUILDING EXTENTION (20M X 6M) & TOILET COMPLEX (1ST FLOOR) AT MARYAM GIRLS ARABIC COLLEGE, BARAKAH ESTATE, THARAVILLU JUNCTION, BATTULU - OYA, SRI LANKA.

DRAWING NO: AJM/D/113

FILE NO: A/D/01

SCALE: AS SHOWN

DATE: ...10/12/2023.....

SHEET SIZE: A-4

CLIENT:

BOARD MEMBERS OF MARYAM GIRLS DRAWN BY :

CHECKED BY :

APPROVED BY :



WE BUILD YOUR DREAM





FRONT ELEVATION



PROJECT:

PROPOSED DRAWIND FOR 1ST FLOOR BUILDING, BUILDING EXTENTION (20M X 6M) & TOILET COMPLEX (1ST FLOOR) AT MARYAM GIRLS ARABIC COLLEGE, BARAKAH ESTATE, THARAVILLU JUNCTION, BATTULU - OYA, SRI LANKA.

DRAWING NO: AJM/D/113

FILE NO: A/D/01

SCALE: AS SHOWN

DATE:/12/2023.....

SHEET SIZE: A-4

CLIENT:

BOARD MEMBERS OF MARYAM GIRLS DRAWN BY : Ale

CHECKED BY :

APPROVED BY :



BOQ FOR THE PROPOSED 1ST FLOOR OF EXTENTION BUILDING (20M X 6M) AT MARYAM GIRLS ARABIC COLLEGE, BARAKAH ESTATE, THARAVILLU JUNCTION, BATTULU - OYA, SRI LANKA.

		SUMM	IARY	
	С	CONCRETE WORKS	Rs.	1,437,499.96
	D	MASONARY WORK	Rs.	904,095.00
1	Ε	ALUMINIUM WORK	Rs.	1,731,132.00
	F	METAL WORK	Rs.	660,000.00
	G	FINISHING WORK	Rs.	1,505,236.00
	н	PAINTING WORK	Rs.	371,520.00
	J	ELECTRICITY WORK	Rs.	410,702.00
		TOTAL		7.020.184.96

Prepared by:

A. J. M. JESLY **B.Tech. Civil Engineering** N.D. Quantity Surveying

I.Q.S.S.L. No: SS 3818

Approved by:

1 of 7

	Total carried to summary	1			1,437,499.96
	Tota				1,437,499.96
	In Column Sharts - C1 & C2: omm In Beams - B2: 6mm	Kg.	54.65	840.00	45,906.00
0.44	Mild Steel Reinforcements In Column Shafts - C1 & C2: 6mm	Kg.	82.21	00.048 L No SS 3818	69,056.40
C-10	In Staire case - 10mm	Kg.	60.62	00.048 antity Surveying	50,920.80
	In Beams - B2: 16mm, 12mm	Kg.	562.22		472,268.16
	In Column Shafts - C1 & C2: 16mm,12mm	Kg.	427.05	840.00 00.048 Civil Engineering	358,718.98
	Tor Steel Reinforcements			L. M. JESLY	\
	1st Floor	1		-	
	to be used.			1. 1. 1. M	
	ordinary spacers, Inevitable laps, chairs and etc. Tor Steel fy=460N/mm2 SLS 375; Mild Steel fy=250N/mm2	Note			
	Reinforcement Rate shall include for all necessary Steel Reinforcement including bends, hooks, tying wire, distance blocks,				
C-07	In Staire case.	Sq.m.	11.65	2,550.00	29,707.50
	In Beams - B2	Sq.m.	17.62	2,550.00	44,924.63
C-05	In Column Shafts - C1 & C2	Sq.m.	3.24	2,250.00	7,290.00
	1st Floor				
	Form work has been measured in the net contact surface measurement between concrete & form work	Note			
	cleaning, wetting etc. Form work has been measured in the same order as in the concrete items	Note			
	Rate shall include for all necessary boarding, supports, erecting, framing, cutting, angles, striking, removal	Note			
	Form work				
	bottom fixed to 6mm dia mild steel S stirrups at 200mmc/c.				
	Supplying all meterials and construction of 100mmx150mm lintels and Sils with Grade 25 (20mm) concrete. Rate to include for formwork and reinforcements with 02 nos of 10mm dia High Yeild steel bars at top and	L.m.	60.00	2,450.00	147,000.00
	In Staire case.	Cu.m.	2.84	19,000.00	53,960.00
	In Beams - B2	Cu.m.	5.87	19,000.00	111,577.50
C-01	In Column Shafts - C1 & C2	Cu.m.	2.43	19,000.00	46,170.00
	1st Floor 1:2:4 (20mm)				
	Plant for mixing, Handling, Hoisting Depositing, compacting curing and making good after removal of form work etc.	Note			
	Rate shall include for	110.000			
	Unless otherwise specified in the respective items all formwork and reinforcement are measured seperately.	Note		-	
	c. so cast as to receive only that finishing on its exposed surface as required				
	b. Made dense with a vibrator.				
	Unless otherwise stated, all conc. Work shall be : a. 1:2:4 (20mm) - 20N/mm2 mix	Note			



D-N	MASONARY				
All ri poin Cutt	te shall include for rough and fair cutting, plumbing angles , forming rebated reveals , rough arches , raking out joints for nting, plastering etc titing and pinning, forming or cutting chases, making good and sundry items of a like nature st Floor Level 5mm thick Brick Wall in 1:5 cement and sand mortar Total	Cu.m.	48.87	18,500.00	904,095.00 904,095.0 0
	Total carried to summary	,			904,095.00
F-A	ALUMINIUM WORKS				504,000.00
Alm Mete All A 1470 All A 1570 Al	nunium Doors and windows terial Almuinium sections shall be fully treated exturded Almunium alloy sections in accordance with BS 70,1471, 1473, 1474 and suitable for the purpose employed. Alminium sections shall present clear , straight and sharply defined lines . They shall be free from fects impairing strength, appearance and durability. ish Alminium extrusions shall be Bronze anodized to a thickness of micron 10-15 rews and Hardware items ncealed screws Nuts , bolts ,rivets and other fastening devices shall be of aluminium Non - magnetic inless steel or other approval corrosive resistant materials if visible they shall blend with the finish of the ming aluminium sections rdware items such as Hinges . Handles catcher fixtures etc Shall be stainless steel				



	Total Control of the				
	All Aluminium members shall be factory fabricated to the best standard of workmanship underexperienced		T		
1	factory supervision and control				
	Materials , method of fabrication assembly installation fastenings, supports, braces, operating parts and the		1	1	
1	like shall be in accordance with the approved shop drawings.	1	1	1	
1	All joints in frames are corners, junctions and intersections shall be mechanically jointed and be such that	1	1	1	
	when assembled they are as strongand rigid as adjoining sections. Due care must be taken to ensure that all			1	
	joints are water tight ans leak -proof Joint should not be visible or nor the finished surfaces				
	Provisions must be made for expansion and contraction in horizontal and vertical members which are		1		
1	exposed to the weather or elements. Any distortion of members or any glass cracked or broken as a result	1			
1	of inadequate provisions must be rectified by the contractor at his own expense				
	All werks shall be securely installed and anchored position. Set plumb square and level in accurate	1			
	alignment with other work All in accordance with the approved shop drawings to the Architects		1		
1	Satisfaction				
	The allowable tolerance in lines of specified dimensions shall be plus miuns 1.5mm				
	Submissions				
		1			
1	The Contractor shall submit shop drawings showing the following information where appropriate to the item				
	Layout (sectional plan and elevation) of complete assembly full size sections of members methods of	1			
	assembly methods of glazing methods of installation, including fixings caulking flashing provisions for vertical				
	and horizontal expansion junctions and trim to adjoining surfaces fittings and accessories				1
	The Contractor shall submit certificates from the aluminium manufacture and or approved testing				1
	loboratory which attest that the coating thickness offered is as specified Fabricate supply and installation of				1
	following				
İ	GROUND FLOOR				
	Aluminium door and windows as above described with bronze anodized (10-15 micron) frame mullions and			1	
	transom and additional strengthening section where necessary and 5mm tinted float glass snap on			1	
	glazing beads neoprene gaskets for glazing, plugging and screwing at jambs, heads, sills, painting one			1	
	side with non - hardening mastic removable protective tape etc			1	
E-01	Aluminium door type D1 5'-7" x 6'-9" (1'-3") 1ST Floor, with 60 - 80 micron powder coated Two sashes door				
	with glazed fixed with pannel on top .Rate to include for heavy quality door lock 2 pairs 12" stainless steel				
	handle wool felt threeaded bar 5mm thick clear colour glass and bottom both sides 3mm thick pyc laminiated				
	sheet all approved quality with above extrusion All complete as per plan as directed by Engineer				
F 00		Sq.m	16.80	18,225.00	306,180.00
E-02	Aluminium door type W1 6'-0" x 9'-9" (1'-3") 1ST Floor, with 60 - 80 micron powder coated four sashes door				
	with glazed fixed with pannel on top. Rate to include for heavy quality door lock 2 pairs 12" stainless steel				
	handle wool felt threeaded bar 5mm thick clear colour glass and bottom both sides 3mm thick pvc laminiated				
	sheet all approved quality with above extrusion All complete as per plan as directed by Engineer				
		Sq.m	72.00	19,791.00	1,424,952.00
	Total				1,731,132.00
	Talal and tala				
	Total carried to summary				1,731,132.00



F-01	F-Metal work Structural steel work Rate shall include for: a. all shop fabrication work including cutting drilling bolting riveting welding grinding delivering unloading hoisting erecting & fixing b. two coats of matt black oil paint (Lanka oil or equivalent) after treating with a coats of anticrossive paint to all exposed faces of trusses.purlins, hiprafters and steel main joints in ceiling. FIRST FLOOR S/F Stainless steel/ GI Iron hand railing in Staircase of 2" dia main bar 1 1/4" dia vertical members at not morethan 2"-6" internal and 2 Nos 3/4" dia horizontal members hand rair hight 3"-0" with all necessary accessries and to the approval of Engineer (Prier approval must be obtained before commence the work by producting sample) Railing to be fixed up to First Floor	L.m.	40.00	16,500.00	660,000.00 660,000.00
	Total carried to summary				660,000.00
	G-FINISHER Plastering Rate shall include for:- All temporary rules, screeds, grounds etc. raking out joints of new block work or hacking new concrete for key internal and coved angles joints between new and old plastering arrises quirks inter sections between curved or irregular surfaces etc. and all making good around pipes sanitary fittings and similar fixture.				
G-02 G-03	First Floor level External 16mm Thick plaser in cement and sand 1:4 finised sand rough to the following Walls and Columns Reveals not exceeding 150mm wide 12mm thick plaser in cement and sand 1:3 finished Rough 10mm thick 1:3 cement & sand plastering to finished Rough sides & soffits of beams 10mm thick 1:3 cement & sand plastering to finished Rough slab and soffits of facia.including Staircase side and Soffit	Sq.m. L.m. Sq.m. Sq.m.	220.00 32.40 22.60 180.00	1,120.00 650.00 2,010.00 2,010.00	246,400.00 21,060.00 45,426.00 361,800.00

0

G-05	Internal 16mm Thick plaser in cement and sand 1:1:5 finised smooth with lime putty to the following Walls and Columns 10mm Thick plaser in cement and sand 1:3:finised sommth with lime putty to the following	Sq.m.	210.00	1,200.00	252,000.00
	Paving				
	Rate shall include for. All temporary rules ,screeds, grounds etc all normal cutting arrises,rounded angles and edges and the like, bedding and pointing making good between different surfaces and between new and old work making good around pipes sanitary firttings and other fixtures cleaning down and protecting upon completion				
G-06	Hall 20mm rendering in cement and sand 1:3 finished smooth with red cement floating	Sq.m.	147.00	1,850.00	271,950.00
G-07	Portiko 20mm rendering in cement and sand 1:3 finished smooth with red cement floating	Sq.m.	16.00	2,100.00	33,600.00
G-08	Skirting Skirting 12mm x 100mm in 1:3 Ct. Sand projected or flush to wall with colour cement floating.	L.ft.	420.00	650.00	273,000.00
	Total				1,505,236.00
	Total carried to Summary	,			1,505,236.00



	II Deletine	1			
- 4	H - Painting				
- 1	Rate shall include for				
1	All preparation of surfaces cleaning down smoothing, knotting, stopping etc protectin of floors and fittings,				
	removing and replacing door and window furniture and cleaning window etc, upon complection				
	Plastered Surfaces				
1	1st floor	1			
- 1	External work				
	Prepare and apply two coats of weather shield emulsion paint colour (CIC weather shield range of	1			
- 1	equivalent) to the following:	1			
	Walls, columns and facia	Sq.m.	196.00	650.00	127,400
2000	Preparing sarfaces and applying 1 coats of wall filler at all plastered surfaces external	Sq.m	196.00	850.00	166,600
	Internal Work	loq	100.00	300.00	,,,,,,,,
	Preparing surfaces, applying skim coat, applying 1 coats of wall filler at all plastered surfaces and two coats		1		
	of emulsion paint, colour (CIC range or equivalent) to the following;	1			
200	Walls & columns	Ca m	184.00	350.00	64,400
		Sq.m.	100000000000000000000000000000000000000		13,120
1-04	Soffit of suspended floor slab, beam & sunshade	Sq.m.	41.00	320.00	13,120
	Total				371,520
	Total carried to Summary				371,520
	J- Electrical Installation				
H	All items are to be as shown in Drg No and as described in the standard specification ICTAD and as				
- 1	specifically modified herein		1		
- 1	y # 100 to 100	1			
- 1	Note;				
- 1	Electrical items are to be of the following makes				
- 1	a) Electrical switches & socket outlets MK Crabtree, PDL.Tenby, Clipsal or equivalent				
- 1	b) Distribution Boards				
	MEM Fuses (British make assembled locally) or consumer Unit type consisting of MCB, or equivalent British,		1		
- 1	french or German Make.	1	1		
	c) Fans: Usha, KDK(Japanese)	1			
	National(Japanese)GEC (UK)	1			
	d) Switch Gear:- Main switches MCB 's MCCB"s MEM (British make) Crabtee, kloeknpr Noeller, Morlin				
	Gem ,MK or equivalent				
- 1	e) ELEB Current Operated :-				
- 1	Cerbtree, MK,BBC or equivalent				
	f) Fluorescent Fittlings	1			
1	The choke, starter & capacitor should be of good quality, British, French, German or equivalent & the tube	1			
- 1	should preferably, Thom, Philips, National or equivalent. The Fluorescent fittings should be fabricated in guage	1	1		
	not similler than 26" GI or Aluminium with two coats of anticorrosive paint with approved colour of enamel				
	paint.				
- 1	Type of wiring:- Semi concealed and fully concealed conduit.				
	Type of fittings:- To be decided by the Architect				
	S/F Bracket lamp (water tight) with wiring all complete to working order	No	8.00	4,813.00	38,504
-U1 h		No	22.00	5,097.00	112,134
	Supply and fixed soffit bracket LED 18W lamp with wiring, switch, etc.——do——	1			22,400
-02	Supply and fixed soffit bracket LED 18W lamp with wiring, switch, etc.——do—— Supply and fixed bood lamp with wiring, switch, plass shad and builb etc.——do——	No	4.00	2.000.00	
-02 -03	Supply and fixed hood lamp with wiring, switch, glass shad and buib etcdo	No No	4.00	5,600.00 5,615.00	
-02 -03 -04	Supply and fixed hood lamp with wiring, switch, glass shad and buib etc.——do—— Supply and fixed 13Amp Universal outlet socket with wiring and switch etc——do——	No	8.00	5,615.00	44,920
-02 -03 -04 -05	Supply and fixed hood lamp with wiring, switch, glass shad and buib etc.——do—— Supply and fixed 13Amp Universal outlet socket with wiring and switch etc——do—— S/F 15Amp socket outlet ——do——	0.000			44,920
-02 -03 -04 -05 -06	Supply and fixed hood lamp with wiring, switch, glass shad and buib etc.——do—— Supply and fixed 13Amp Universal outlet socket with wiring and switch etc——do—— S/F 15Amp socket outlet ——do—— Ceiling fans 1400mm dia, swing with regulator and 5 speed additional control switch, (Bajaj regal/	No No	8.00 8.00	5,615.00 6,329.00	44,920 50,633
02 03 04 05 06	Supply and fixed hood lamp with wiring, switch, glass shad and buib etc.——do——Supply and fixed 13Amp Universal outlet socket with wiring and switch etc——do——S/F 15Amp socket outlet ——do——Ceiling fans 1400mm dia, swing with regulator and 5 speed additional control switch, equivalent) ——do——	No	8.00	5,615.00	44,92
02 03 04 05 06	Supply and fixed hood lamp with wiring, switch, glass shad and buib etc.——do—— Supply and fixed 13Amp Universal outlet socket with wiring and switch etc——do—— S/F 15Amp socket outlet ——do—— Ceiling fans 1400mm dia, swing with regulator and 5 speed additional control switch, equivalent) ——do—— Supply and fixed ABC Box with 9 Nos brackers. With main & trip switch and wiring including 30Amp main and	No No No	8.00 8.00 8.00	5,615.00 6,329.00 12,539.00	44,92 50,63 100,31
-02 -03 -04 -05 -06	Supply and fixed hood lamp with wiring, switch, glass shad and buib etc.——do—— Supply and fixed 13Amp Universal outlet socket with wiring and switch etc——do—— S/F 15Amp socket outlet ——do—— Ceiling fans 1400mm dia, swing with regulator and 5 speed additional control switch, (Bajaj regal/equivalent) ——do—— Supply and fixed ABC Box with 9 Nos brackers. With main & trip switch and wiring including 30Amp main and 30Amp trip switch crabtnew etc.(orange type or equivalent)	No No No	8.00 8.00 8.00	5,615.00 6,329.00 12,539.00 18,900.00	44,92 50,63 100,31 18,90
02 03 04 05 06 07	Supply and fixed hood lamp with wiring, switch, glass shad and buib etc.——do——Supply and fixed 13Amp Universal outlet socket with wiring and switch etc——do——S/F 15Amp socket outlet ——do——Ceiling fans 1400mm dia, swing with regulator and 5 speed additional control switch, (Bajaj regal/equivalent) ——do——Supply and fixed ABC Box with 9 Nos brackers. With main & trip switch and wiring including 30Amp main and 30Amp trip switch crabtnew etc.(orange type or equivalent) Earth Electrode G.I. Pipe 50mm dia	No No No No No	8.00 8.00 8.00 1.00 1.00	5,615.00 6,329.00 12,539.00 18,900.00 1,300.00	44,92 50,63 100,31 18,90 1,30
02 -03 -04 -05 -06 -07 -08 -09	Supply and fixed hood lamp with wiring, switch, glass shad and buib etc.——do—— Supply and fixed 13Amp Universal outlet socket with wiring and switch etc.——do—— S/F 15Amp socket outlet ——do—— Ceiling fans 1400mm dia, swing with regulator and 5 speed additional control switch, (Bajaj regal/equivalent) ——do—— Supply and fixed ABC Box with 9 Nos brackers. With main & trip switch and wiring including 30Amp main and 30Amp trip switch crabtnew etc.(orange type or equivalent) Earth Electrode G.I. Pipe 50mm dia Supply and fixed 7/0.044 Twin core wire (provisional)	No No No	8.00 8.00 8.00	5,615.00 6,329.00 12,539.00 18,900.00	44,92 50,63 100,31 18,90 1,30
-02 -03 -04 -05 -06 -07 -08 -09 -10	Supply and fixed hood lamp with wiring, switch, glass shad and buib etc.——do—— Supply and fixed 13Amp Universal outlet socket with wiring and switch etc——do—— S/F 15Amp socket outlet ——do—— Ceiling fans 1400mm dia, swing with regulator and 5 speed additional control switch, (Bajaj regal/equivalent) ——do—— Supply and fixed ABC Box with 9 Nos brackers. With main & trip switch and wiring including 30Amp main and 30Amp trip switch crabtnew etc.(orange type or equivalent) Earth Electrode G.I. Pipe 50mm dia Supply and fixed 7/0.044 Twin core wire (provisional) Supply and fixed service bracket 5'-0" long 2 1/2" x 2 1/2" x 1/4" angle iron fixed to wall including painting 2	No No No No No Lm	8.00 8.00 1.00 1.00 40.00	5,615.00 6,329.00 12,539.00 18,900.00 1,300.00 240.00	44,92 50,63 100,31 18,90 1,30 9,60
-02 -03 -04 -05 -06 -07 -08 -09 -10	Supply and fixed hood lamp with wiring, switch, glass shad and buib etc.——do—— Supply and fixed 13Amp Universal outlet socket with wiring and switch etc.——do—— S/F 15Amp socket outlet ——do—— Ceiling fans 1400mm dia, swing with regulator and 5 speed additional control switch, (Bajaj regal/equivalent) ——do—— Supply and fixed ABC Box with 9 Nos brackers. With main & trip switch and wiring including 30Amp main and 30Amp trip switch crabtnew etc.(orange type or equivalent) Earth Electrode G.I. Pipe 50mm dia Supply and fixed 7/0.044 Twin core wire (provisional)	No No No No No Lm	8.00 8.00 8.00 1.00 1.00	5,615.00 6,329.00 12,539.00 18,900.00 1,300.00	44,92 50,63

